P & G STRUCTURES PTY LTD

CONSULTING-STRUCTURAL-CIVIL

ABN: 20 129 006 935 ACN: 129 006 935

Suite 605, 147 Pirie Street, ADELAIDE SA 5000

Ph/Fax: (08) 8223 2022

Email: admin@pgstruct.com



Stormwater management report For Proposed residential/commercial development At 42-46 Unley Road Unley

Client: Otello Projects

Date: 25/02/2025

Job No: PG23017

Introduction

This report is prepared at the request of Otello Projects. P&G Structures were engaged to prepare Stormwater management report to support the Planning submission for the development.

This development is a multi-use residential and commercial building. The site is within City of Unley Council area. The site has street boundary along Unley Rd and Irwin Lane.

Stormwater management analysis

Design Criteria

The design criteria is established based on council guidelines provided Russell King of City of Unley in an email dated 24/03/2023 and City of Unley planning RFI, dated 2/12/2024.

The requirements are as follows:

Stormwater detention: Given the drainage limitations in the localised area council are expecting stormwater detention requirements restricting post development 1% AEP flows to 10% predevelopment flows adopting a 60% impervious area pre development.

Street discharge: Discharge to Irwin lane is preferred. Stormwater to be directly connected to underground street pipe.

WSUD measures: Council encourage on site retention, such as permeable paving

Pre-development site conditions

This site is approximately 1115m2 and has a single residence .The stormwater from the site is discharged to the kerb watertable on Unley Rd and Irwin Lane.

Post-Development site conditions

The proposed development is a multi-storey building with approximate roofed area of 895sqm.

All paved areas that are exposed to stormwater runoff and are not under cover are proposed to be constructed with permeable paving. The runoff from the paved areas is undetained and is discharged into the underground stormwater system on Irwin Lane.

The sump that collects surface stormwater runoff is fitted with Oceanguard Pollutant filter.

The runoff from the roof is directed to a stormwater detention tank with detention volume of 13.5 kL.

The detention tank is discharged to the street via a pump, which restricts the outflow to the street as per the council guidelines:

- post development 1% AEP flows are limited to 10% pre-development flows
- 60% impervious area pre development.

The detention tank is proposed to be placed below ground in the carpark area. Overflow pipe is connected to the top of the tank to allow for emergency overflow of 100year event.

The detention tank overflow and the surface runoff are connected to the street underground pipe on Irwin Lane.

Flood hazard

The site is positioned within a flood zone and is subjected to 100mm high flood water.

The floor level is FL11.32 and is selected based on entry point to the building of 9.97 and allows 100mm freeboard above top of kerb level. This will allow 250mm freeboard above flood levels.

Glifehrva

Galina Petrova MSc(StrEng) FIEAust CPEng NER(Civil)NER(Str)

For P&G Structures

Attachments:

- Stormwater calculations
- Drawings PG23016-C1 to C3

SURVEY LEGEND

61.30 SPOT HEIGHT

<u>^</u> TBM

WATER METER

T STOBIE POLE

SEWER

✓ GAS

9D DOMESTIC OUTLET

NOTES:

- 1. STORMWATER LAYOUT IS INDICATIVE ONLY, AND MAY CHANGE TO SUIT SITE CONDITIONS.
 THE INTEGRITY OF THE STORMWATER DRAINAGE DESIGN SHALL BE MAINTAINED AT ALL TIMES.
- 2. REFER TO ARCHITECTURAL SITE PLAN FOR ALL SET OUT DIMENSIONS, LANDSCAPING AND ADDITIONAL DETAILS.
- 3. <u>BOUNDARY NOTE:</u> BOUNDARY LOCATIONS ARE BASED ON FENCES ONLY. IT IS STRONGLY RECOMMENDED THAT AN IDENTIFICATION SURVEY BE DONE TO ESTABLISH TRUE BOUNDARIES.
- 4. <u>EXISTING SERVICES NOTE:</u>
 APPROVAL WILL NEED TO BE SOUGHT FROM RELEVANT AUTHORITIES FOR ANY EXISTING SERVICES TO BE RELOCATED.
- 5. <u>SITE IS VEGETATED.</u> COMPLETE REMOVAL OF ALL TREES LOCATED WITHIN THE BUILDING PLATFORM MUST BE REMOVED SO AS NOT TO ALLOW ANY FUTURE GROWTH.


 THIS REMOVAL PROCESS MUST INCLUDE THE BASE AND ALL MAJOR ROOT SYSTEMS OF EACH TREE. ANY VOIDS IN THE GROUND AFTER THE REMOVAL OF THE TREE MUST BE BACKFILLED WITH CLEAN MATERIAL TO

CONTINUED:

6. SITE SURVEY NOTE: SITE SURVEY BY OTHERS.

THE SURVEY DOESN'T COVERS GROUND LEVELS ON THE ADJACENT PROPERTY.
IF ANY EXISTING RETAINING WALLS ARE ENCOUNTERED ALONG THE BOUNDARY AND THE LEVELS BOTH SIDES OF THE BOUNDARY DIFFER BY MORE THAN 100mm, CONTACT THIS OFFICE FOR FURTHER ADVICE.

- 7. COUNCIL GENERAL NOTE: ALL WORKS BEYOND THE PROPERTY BOUNDARY ARE TO BE TO COUNCILS REQUIREMENTS AND STANDARD DETAILS.
- 8. EXISTING BUILDINGS ON BLOCK NOTE: PRIOR TO THE COMMENCEMENT OF SITE EARTHWORKS, IT IS RECOMMENDED THAT ADDITIONAL SITE LEVELS BE TAKEN TO CONFIRM REQUIRED BENCH LEVEL ONCE ALL EXISTING STRUCTURES HAVE BEEN REMOVED OVER THE HOUSE SITE.
- 9. REFER TO ARCHITECTURAL SITE PLAN FOR ALL SET OUT DIMENSIONS, LANDSCAPING AND ADDITIONAL DETAILS.

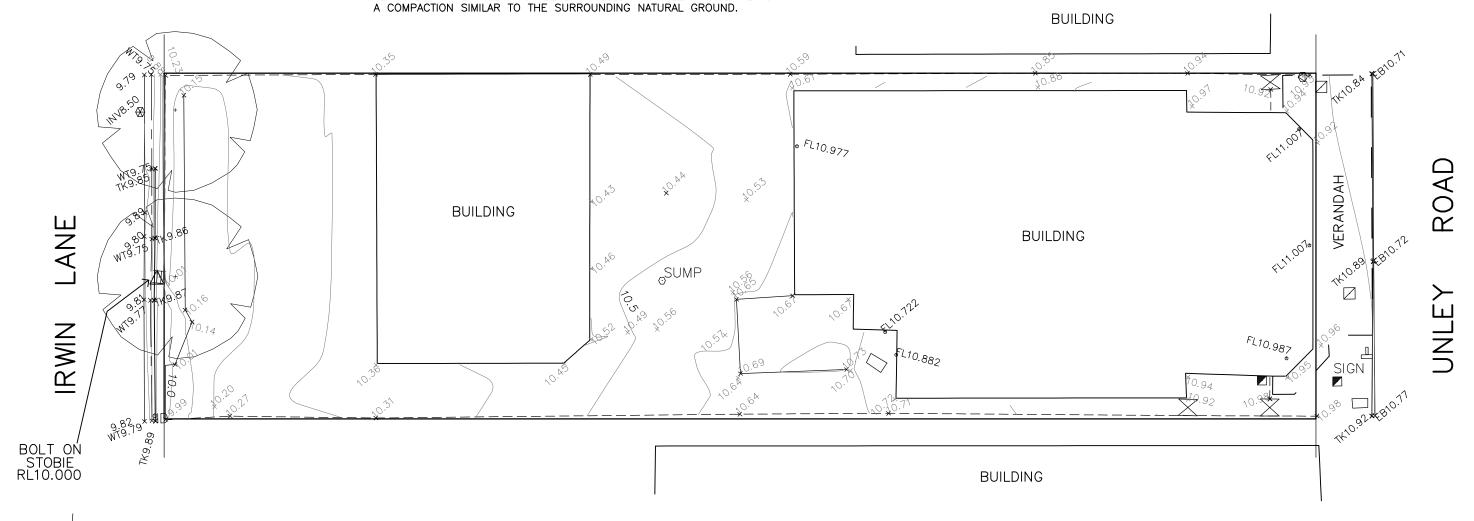



EXISTING CONTOUR PLAN.

SCALE 1:200

				© Copyright NOTE. THIS DOCUMENT MAY ONLY BE USED BY THE INTENDED RECIPIENT (AND ANY OTHER PERSON PG STRUCTURES HAS AGREED CAN USE THIS DOCUMENT) FOR THE PURPOSE FOR WHICH IT WAS PREPARED AND MUST NOT BE USED BY ANY OTHER PERSON OR FOR ANY OTHER PURPOSE.
P2 P1	G.P.	04.2023 04.2023	FOR COUNCIL APPROVAL. FOR COUNCIL APPROVAL.	0 1000 2000 3000 4000 5000
ISSUF:	CHECKED:	DATE:	PEVISION:	A3 SHEET

PRELIMINARY

NOT TO BE USED FOR CONSTRUCTION

P & G STRUCTURES Pty Ltd

CONSULTING - STRUCTURAL - CIVIL ABN 20 129 006 935 ACN 129 006 935

Suite 605 147 Pirie Street Adelaide SA 5000 Ph/Fax: (08) 8223 2022 Mob: 0418 808 171 email: admin@pgstruct.com



	DESIG G.P.
•	DRAWI T.D.
	CHECI G.P.

04.2023

SIGNED:	PROJECT: PROPOSED APARTMENTS
RAWN: D.	42—46 UNLEY ROAD, UNLEY. S.A.


DRAWING TITLE:		
EXISTING (CONTOUR	PLAN.


REFER TO ALL CIVIL SHEETS C1-C3.

CLIENT: OTELLO.

ORIGINAL SIZE:
A3 SHEET
SCALES: AS SHOWN
JOB No: PG230

JOB No: PG23016 DRAWING No: C1 ISSUE: P2

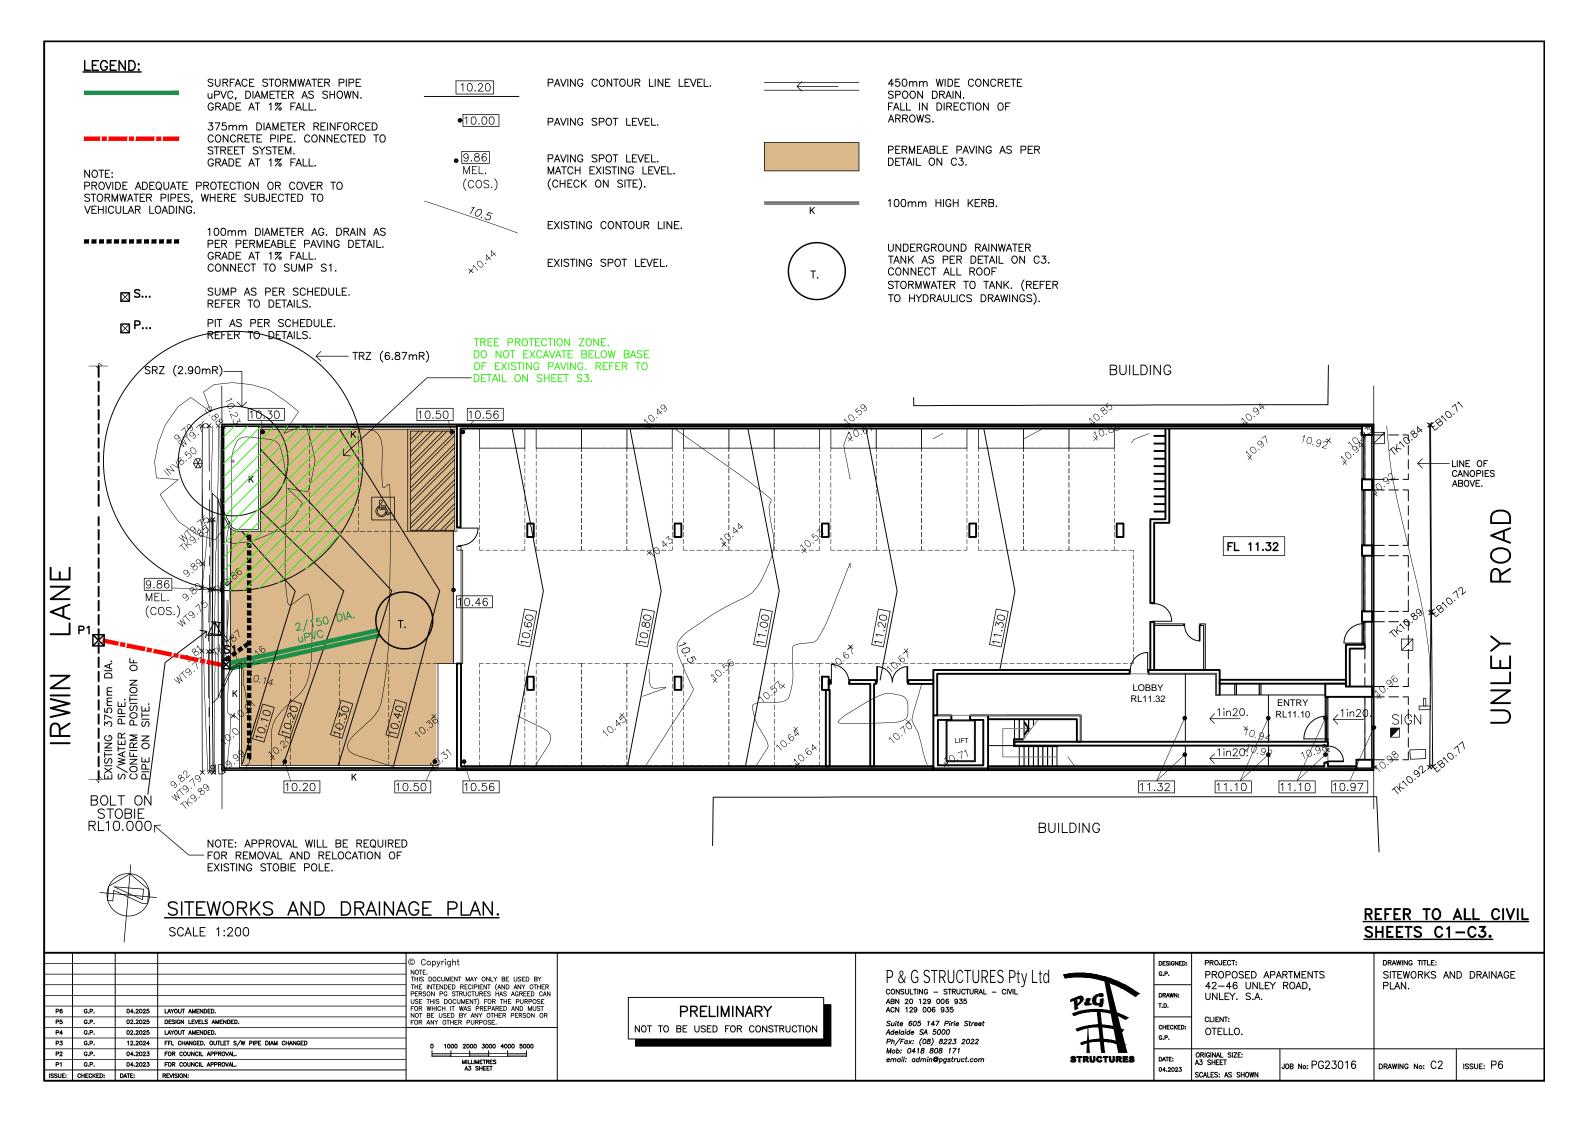

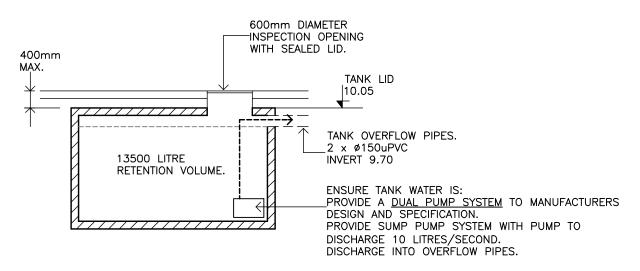


DETENTION TANK DETAIL.

ALL DETAILS AS PER RELEVANT AUTHORITIES.

NOTE: PUMP SYSTEM TO COMPLY WITH AS/NZS 3500.3:2003 SECTION 9, 'PUMPED SYSTEMS.'

- THE INLET AND OVERFLOW OF THE TANK MUST BE FITTED WITH MOSQUITO PROOF. NON-DEGRADABLE SCREENS FORMED FROM 0.315mm DIAMETER MATERIAL AND HAVE A MINIMUM OF 6x7 OPENINGS PER SQUARE CENTIMETRE.

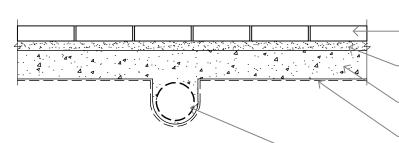

PERMEABLE CLAY BRICK PAVING (E.G. LITTLEHAMPTON PERMEABLE BRICK PAVERS) 80mm DEEP WITH NO FINES JOINTING SAND.

30mm THICK LAYER OF 2mm TO 5mm SCREENING SAND.

200mm THICK LAYER OF 20mm SCREENINGS.

GEOTEXTILE FABRIC.

100mm DIAM AG DRAIN WRAP IN GEOTEXTILE SOCK. PROVIDE 20mm SCREENINGS AROUND. REFER TO LAYOUT FOR LOCATION AND DISCHARGE.

TYPICAL DETAIL OF PERMEABLE PAVING FOR MEDIUM VEHICLE TRAFFIC

SCALE 1:20 (THIS DETAIL IS NOT APPLICABLE FOR TPZ AREA.)

12.2024 PERMEABLE PAVING CHANGED TO BRICK PAVER.

04,2023 FOR COUNCIL APPROVAL

04.2023 FOR COUNCIL APPROVA

REVISION:

SUMP SCHEDULE:

P3 G.P.

P2 G.P.


P1 G.P.

ISSUE: CHECKED: DATE:

SUMP NUMBER	TOP RL	OUTLET IL	INLET IL	SIZE	COVER	NOTES	
S1	9.84 C.O.S.	9.10	9.35	450×450	CLASS D.	GRATED COVER. INSTALL OCEAN GUARD POLLUTANT FILTER TO	
						OCEAN PROTECT SPECIFICATIONS.	
P1	M.E.L.	C.O.S.	9.03	600x600	CLASS D.	SOLID COVER. SUMP TO BE CONSTRUCTED STRICTLY TO COUNCILS SPECIFICATIONS.	

© Copyright

1000 2000 3000 4000 5000

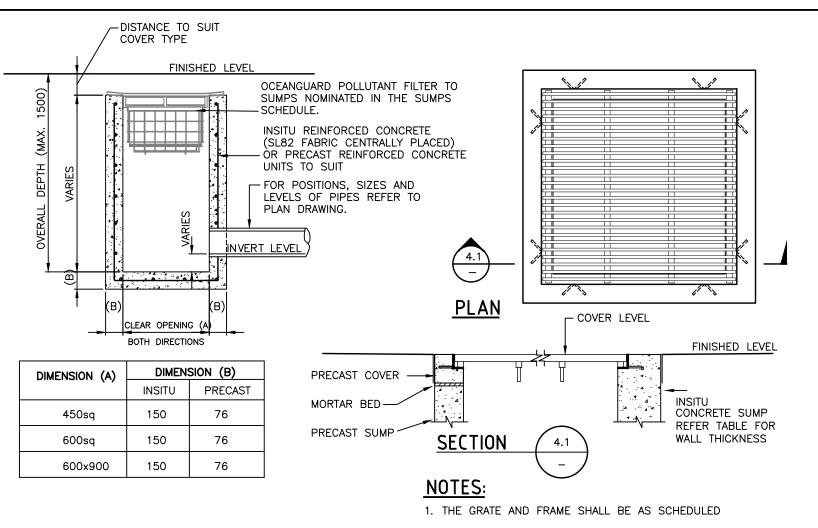


STORMWATER SUMP DETAIL

STORMWATER SUMP GRATE AND FRAME

NOTES: (FOR PRECAST UNITS)

- 1. PENETRATIONS FOR PIPES SHALL BE APPROX 50 GREATER THAN THE O/D OF THE PIPE. PIPES SHALL BE FINISHED FLUSH WITH THE INTERNAL FACE OF THE SUMP. A STIFF MORTAR MIX OF 2:1 SAND:CEMENT SHALL BE PACKED INTO THE SPACE FROM BOTH SIDES OF THE STRUCTURE. THE INTERNAL FACE SHALL BE FINISHED SMOOTH AND A 150 THICK BAND OF CONCRETE SHALL BE POURED OUTSIDE THE SUMP TO SEAL THE PENETRATION
- 2. WHERE SUMPS CONSIST OF MORE THAN ONE PRECAST UNIT THE JOINTS SHALL BE SEALED WITH BUTYL MASTIC SEALANT AROUND THE OUTSIDE AND A 3:1 SAND:CEMENT GROUT ON THE INSIDE OF THE SUMP.

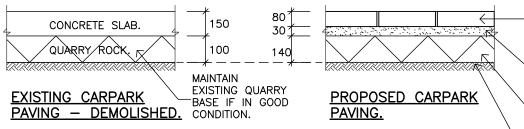

TO 5mm SCREENING SAND. PROPOSED NEW LAYER OF QUARRY ROCK. MAINTAIN EXISTING QUARRY BASE IF IN GOOD CONDITION.

04.2023

TYPICAL DETAIL OF PAVEMENT REPLACEMENT WITHIN TPZ OF SIGNIFICANT TREE.

SCALE 1:20

COPYTIGHT
NOTE.
THIS DOCUMENT MAY ONLY BE USED BY
THE INTENDED RECIPIENT (AND ANY OTHER
PERSON PG STRUCTURES HAS AGREED CAN
USE THIS DOCUMENT) FOR THE PURPOSE
FOR WHICH IT WAS PREPARED AND MUST
NOT BE USED BY ANY OTHER PERSON OR
FOR ANY OTHER PURPOSE. C1-C3.

REFER TO ALL CIVIL SHEETS

P & G STRUCTURES Pty Ltd CONSULTING - STRUCTURAL - CIVIL ABN 20 129 006 935 ACN 129 006 935

Suite 605 147 Pirie Street Adelaide SA 5000 Ph/Fax: (08) 8223 2022 Mob: 0418 808 171



ESIGNED: 6.P.	PROJECT: PROPOSED APARTMENTS
RAWN:	42–46 UNLEY ROAD, UNLEY. S.A.
CHECKED:	CLIENT: OTELLO.

DRAWING TITLE: NOTES AND DETAILS.

ISSUE: P4 JOB No: PG23016 DRAWING No: C3

PERMEABLE CLAY BRICK PAVING

BRICK PAVERS) 80mm DEEP

DO NOT EXCAVATE BELOW OF

EXISTING QUARRY BASE.

WITH NO FINES JOINTING SAND. 30mm THICK LAYER OF 2mm

(E.G. LITTLEHAMPTON PERMEABLE

PRELIMINARY NOT TO BE USED FOR CONSTRUCTION